



Existing North Elevation

Datum 7.00m




Existing East Elevation

Datum 7.00m



Existing South Elevation

Datum 7.00m

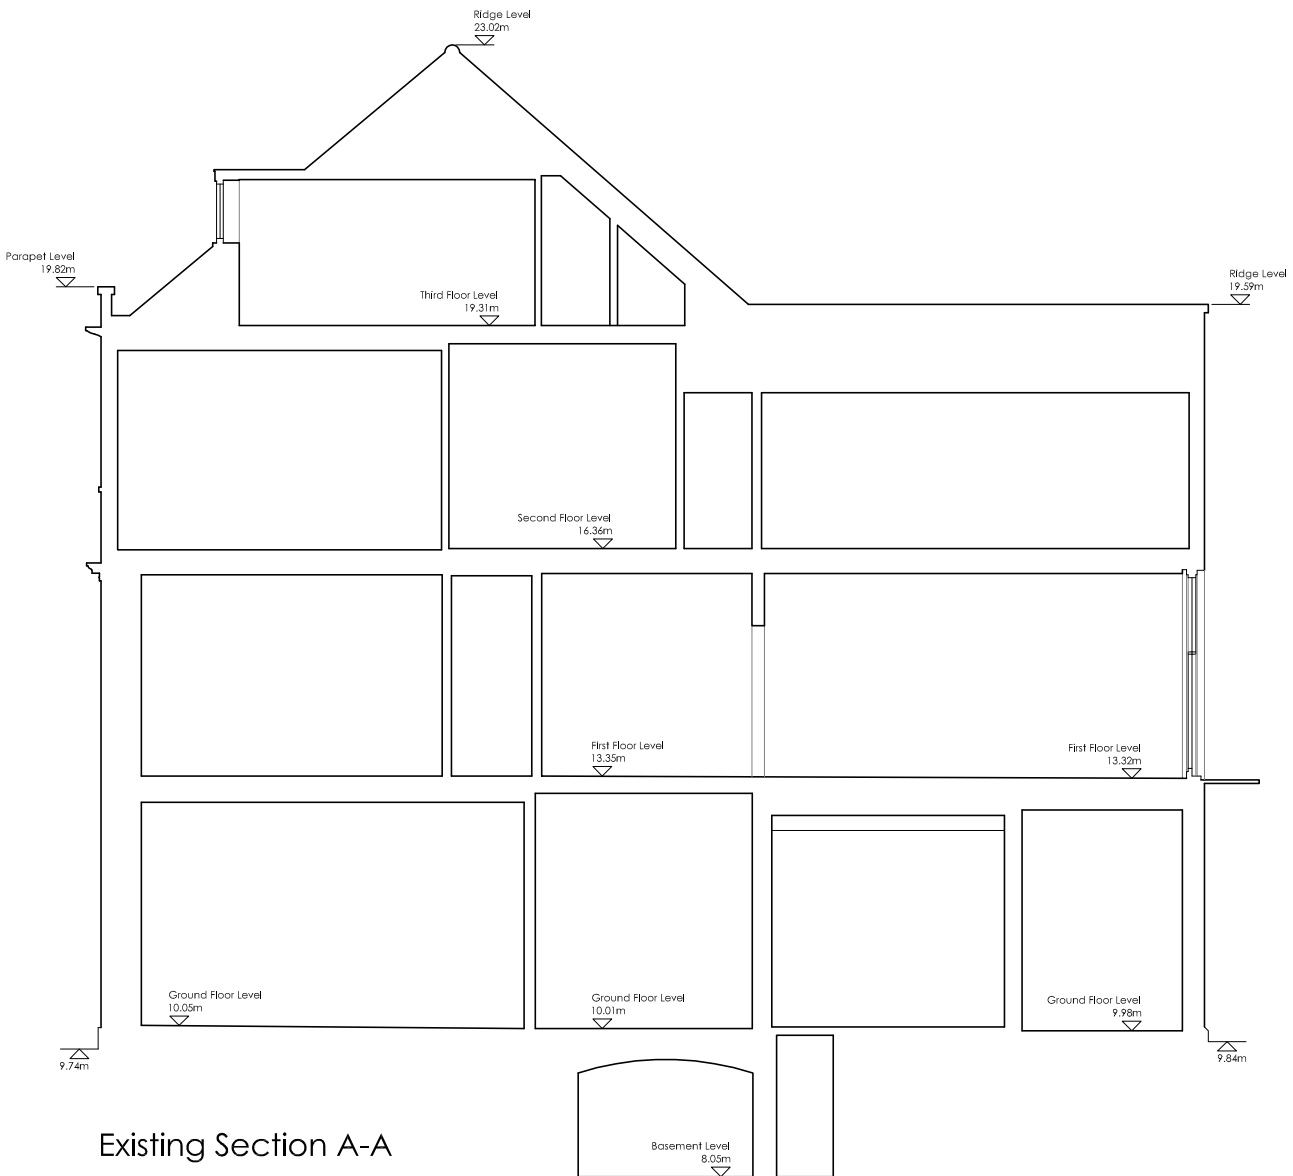

Existing Section A-A

Datum 7.00m

BUILDING SURVEY - LEGEND			
WINDOW DETAIL HEIGHTS:		FALSE CEILING	F/C
FLOOR TO CELL HEIGHT	C	CEILING	C/L
CELL TO HEAD OF WINDOW	C/H	SKYLIGHT	S/L
CELL TO SPRING	C/S	UNDERSIDE	U/S
ARCH DETAIL HEIGHTS:		OVERHEAD	O/H
FLOOR TO SPRING	S	FLOOR LEVEL	FL
FLOOR TO HEAD	H	THRESHOLD LEVEL	TL
		BEAM LEVEL	BL
		SOFFIT LEVEL	SFL
DRAINAGE:		SAVE LEVEL	EL
INSPECTION COVER	IC	RIDGE LEVEL	RL
GULLY	G	FINISHED FLOOR LEVEL	FTL
RAIN WATER PIPE	RWP	SLOPE UP	S/UP
SOLVENT PIPE	SVP	UP ARROW	U/ARROW
VENT PIPE	VP	FLOOR TO CEILING HEIGHT	F/C/H

All Levels Are Based on TBM Value: 10.00m
Situating on Floor Level of Bow Window of No 221
on Ground Floor Plan.
North Point is Indicative Only.

All Dimensions to be Verified on Site Prior to Construction.
No Dimensions to be Scaled from this Drawing.



Measured Building Survey & Cad Consultancy

Contact us:
mob: +44 (0) 7786 952804
mob: +44 (0) 7880 984831
email: info@perceptumdesign.co.uk
website: www.perceptumdesign.co.uk

Project:
Dial House
Existing Elevations & Section
Example Drawing

Client:

Date: 2011	Drawn:	Checked:
Scale: 1:100 @ A2		
Project No: EX/01	Drawing No: EX/01/02	Revision: